






TYPICAL FLOOR PLAN (BLOCK-A)
SCALE: 1:100

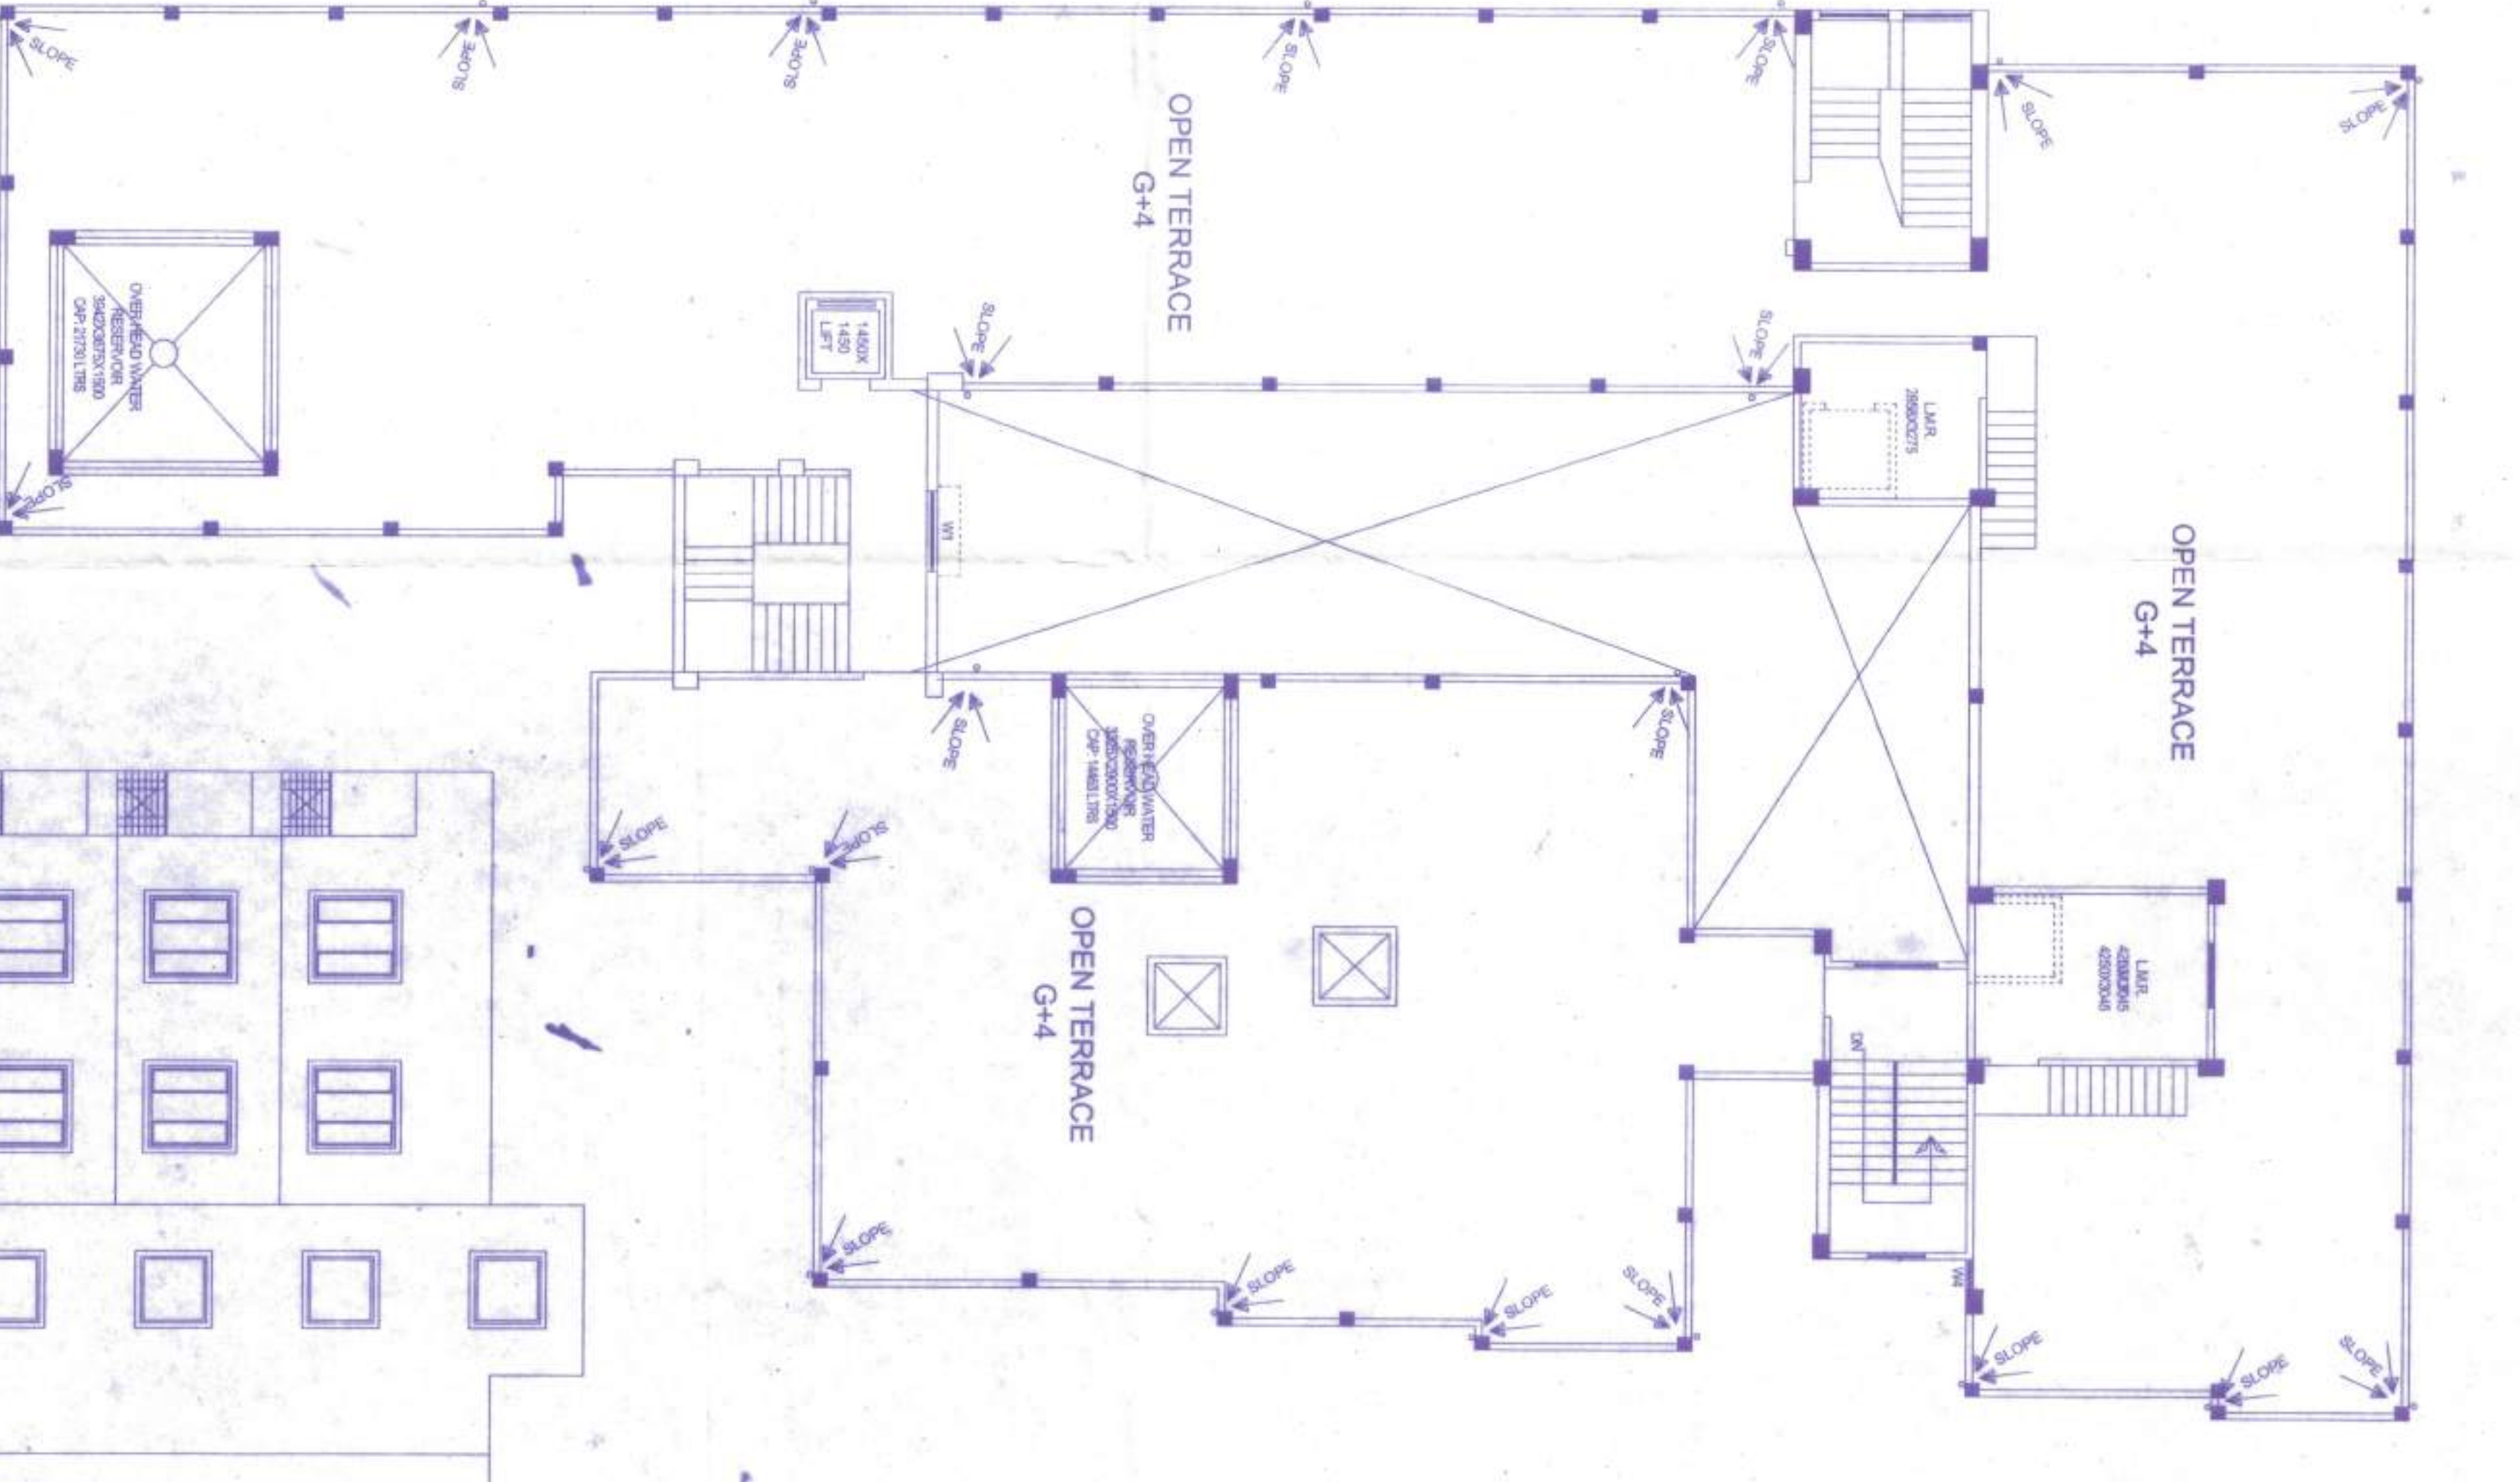


ROOF PLAN (BLOCK-A)
SCALE: 1:100

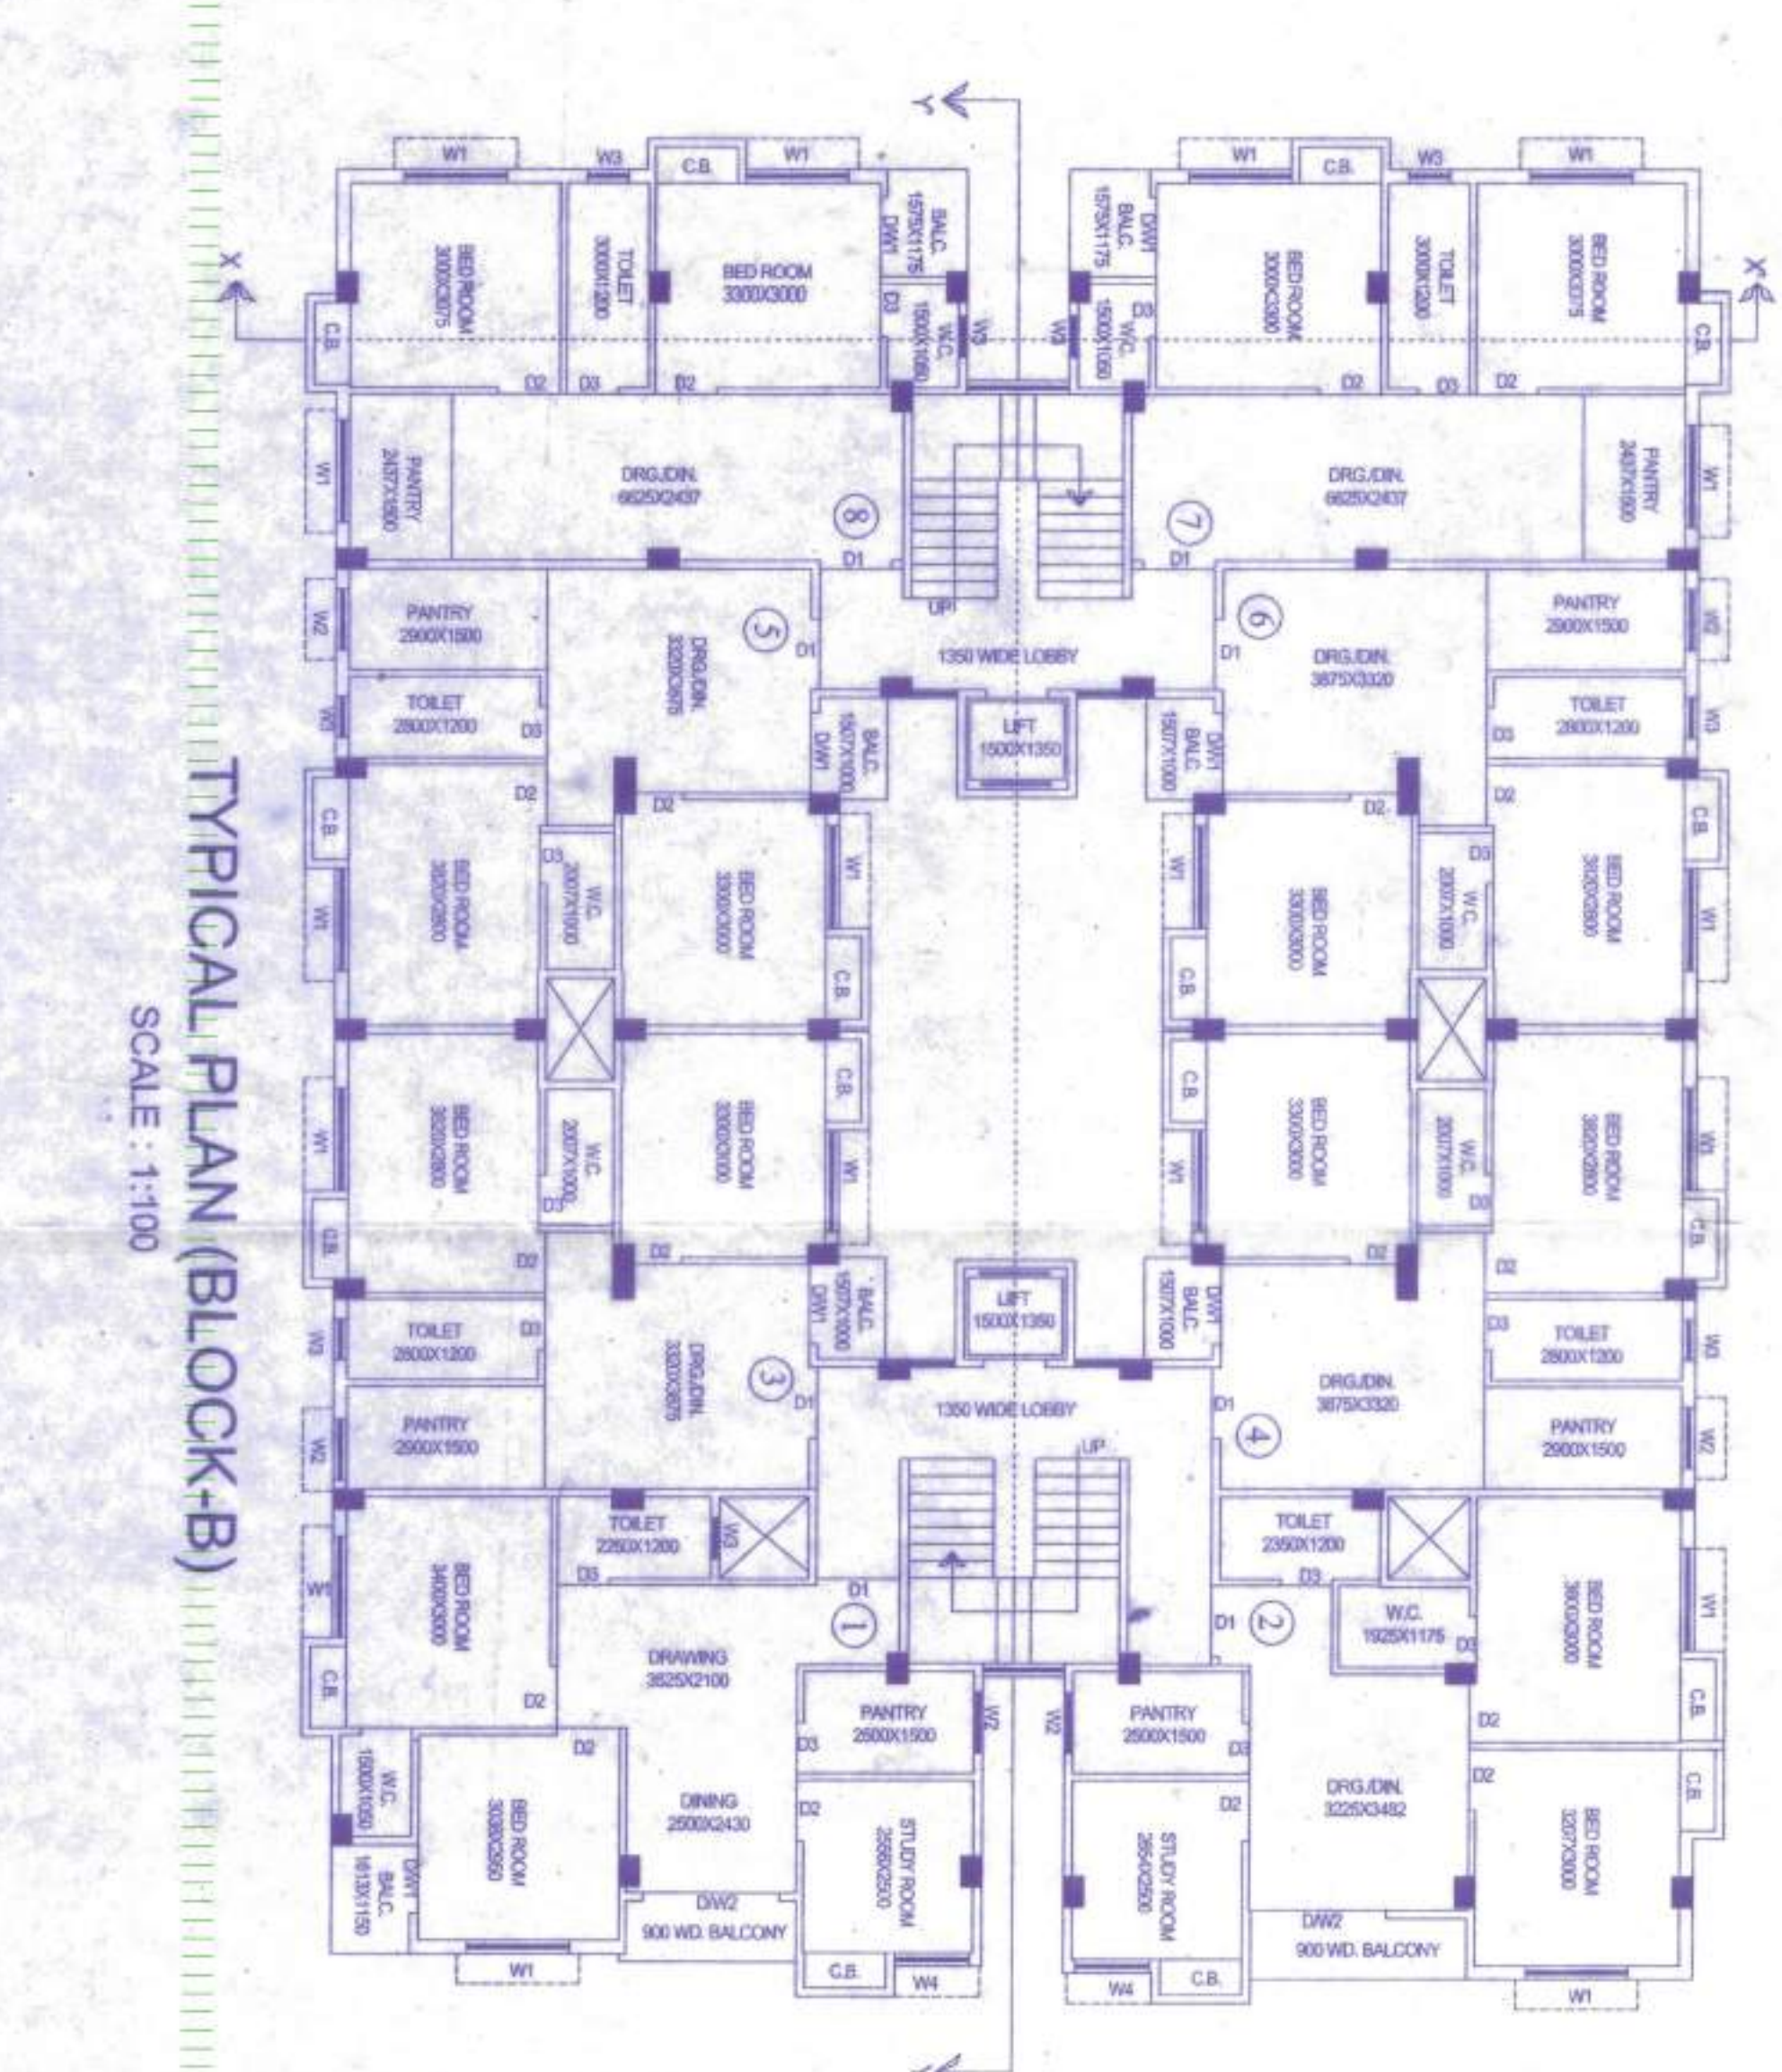


TYPICAL FLOOR PLAN (BLOCK-B)
SCALE: 1:100

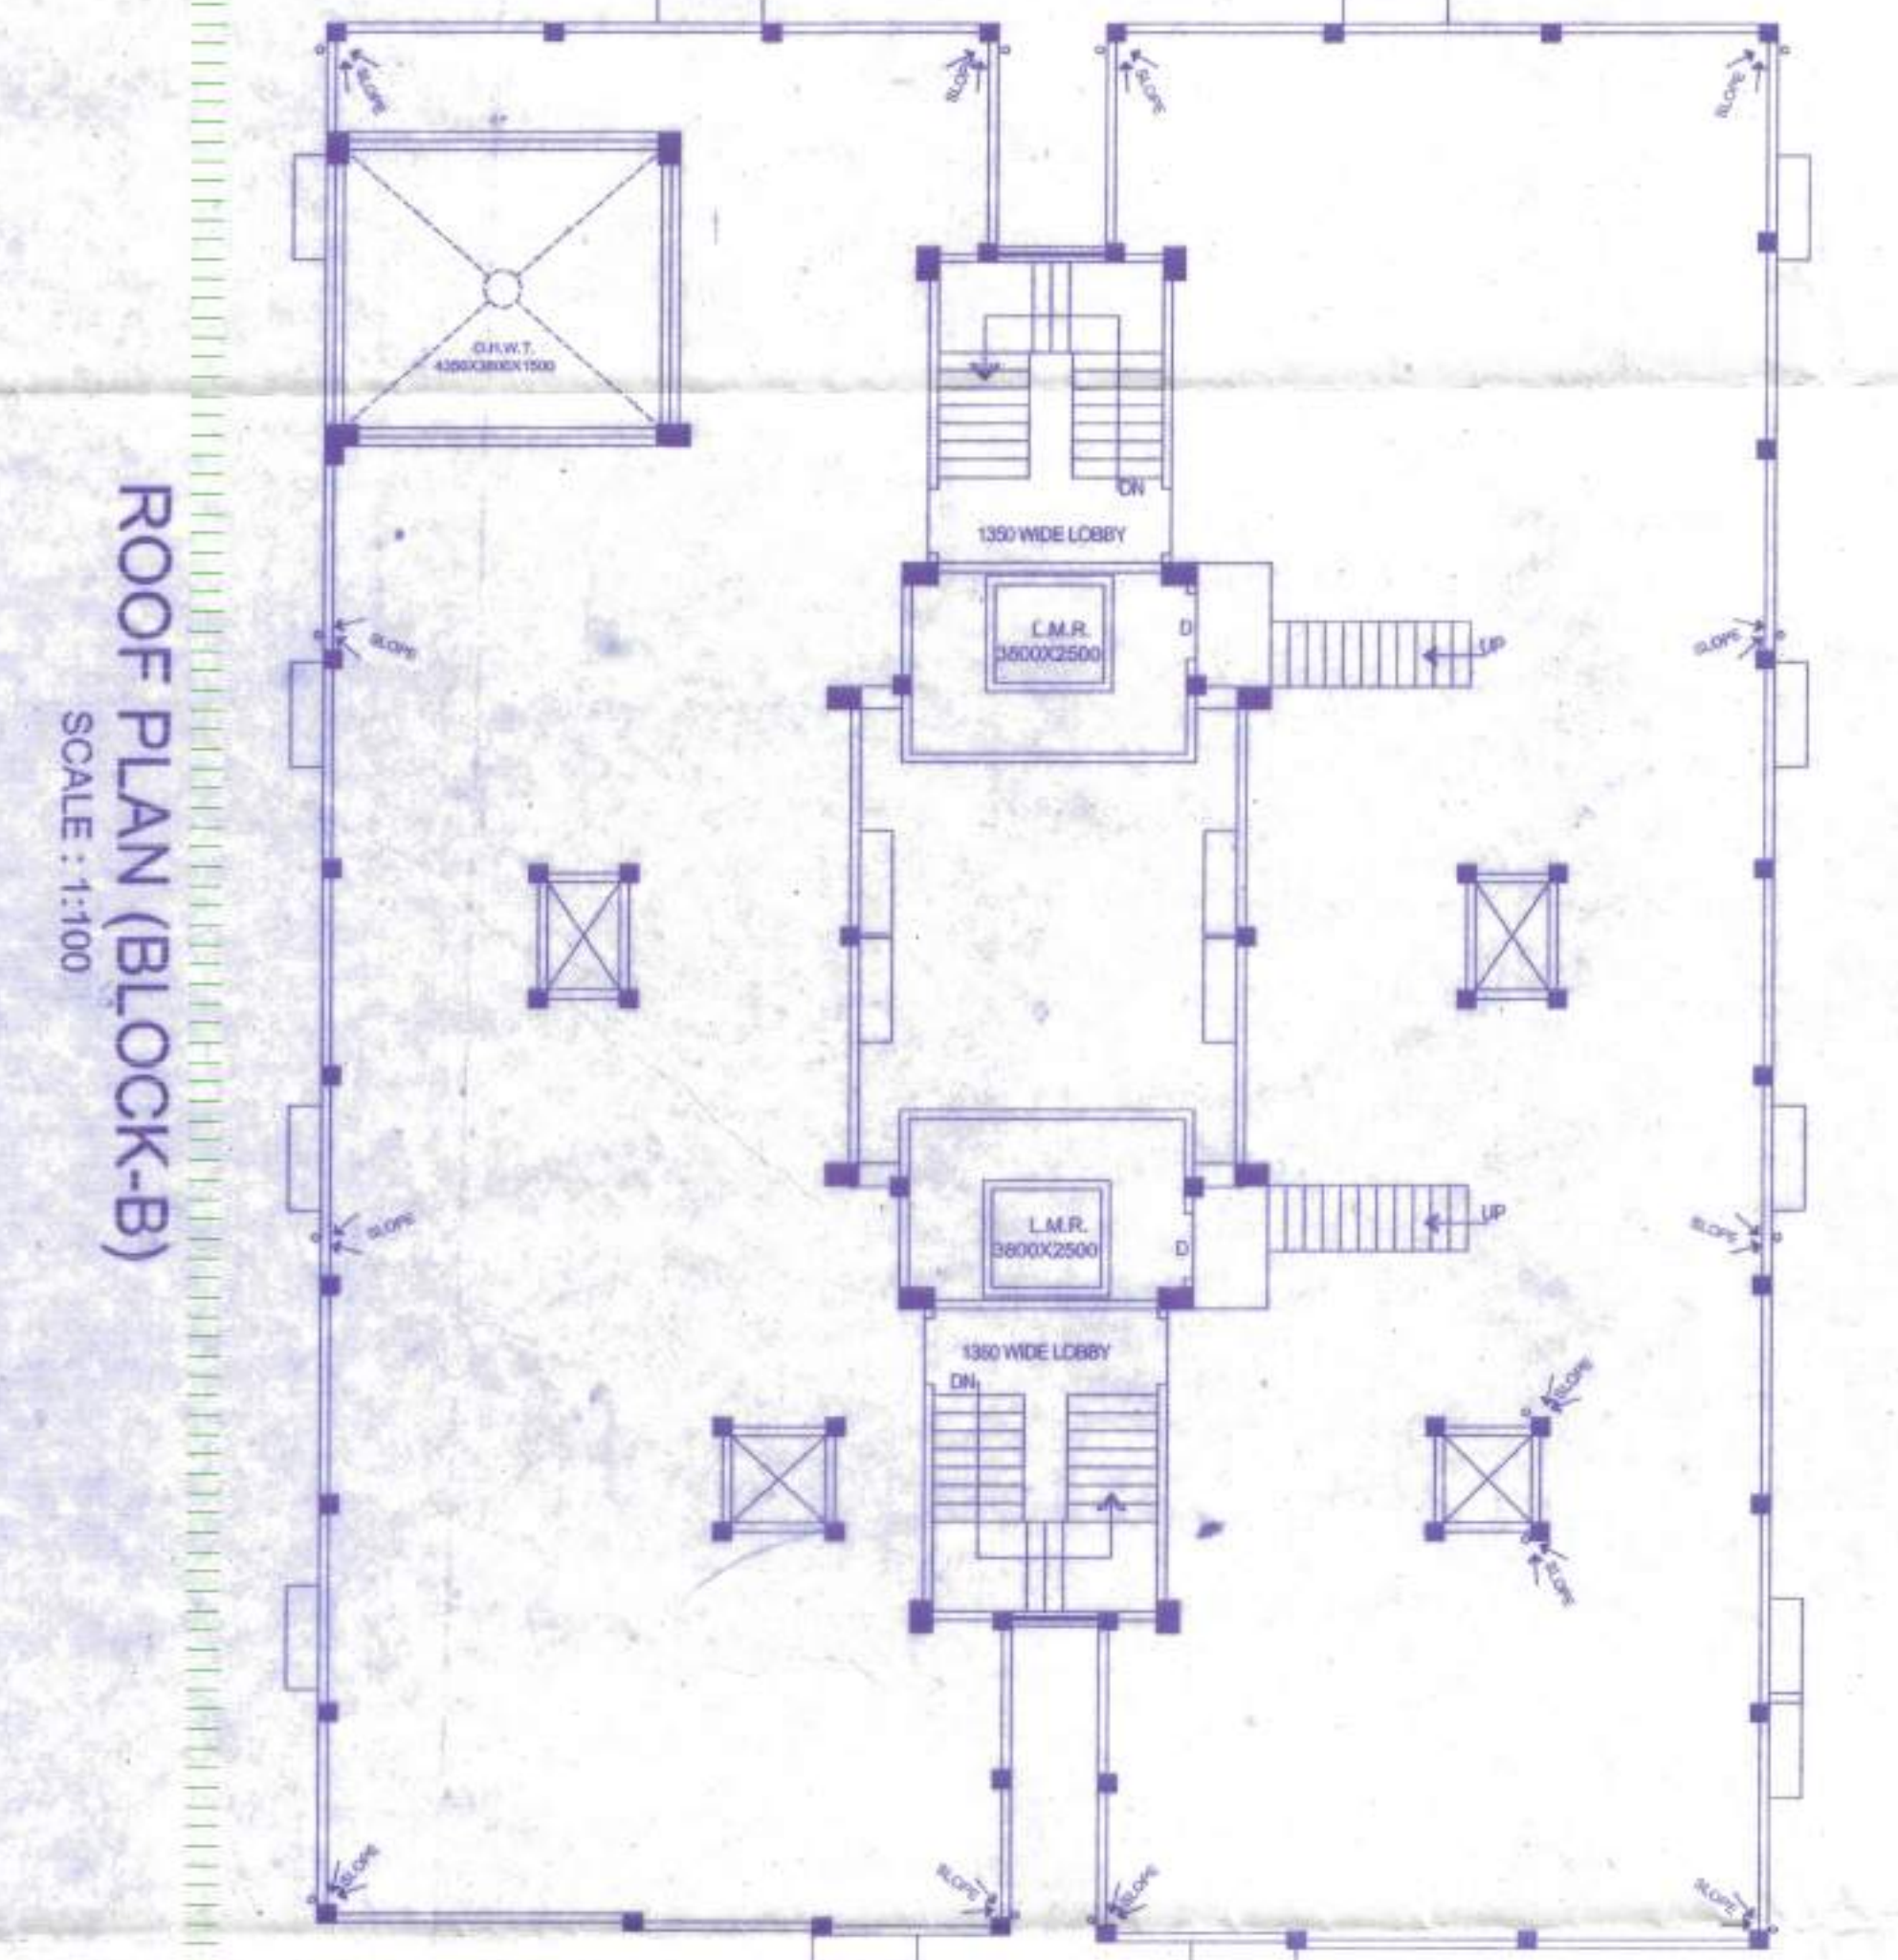


ROOF PLAN (BLOCK-B)
SCALE: 1:100

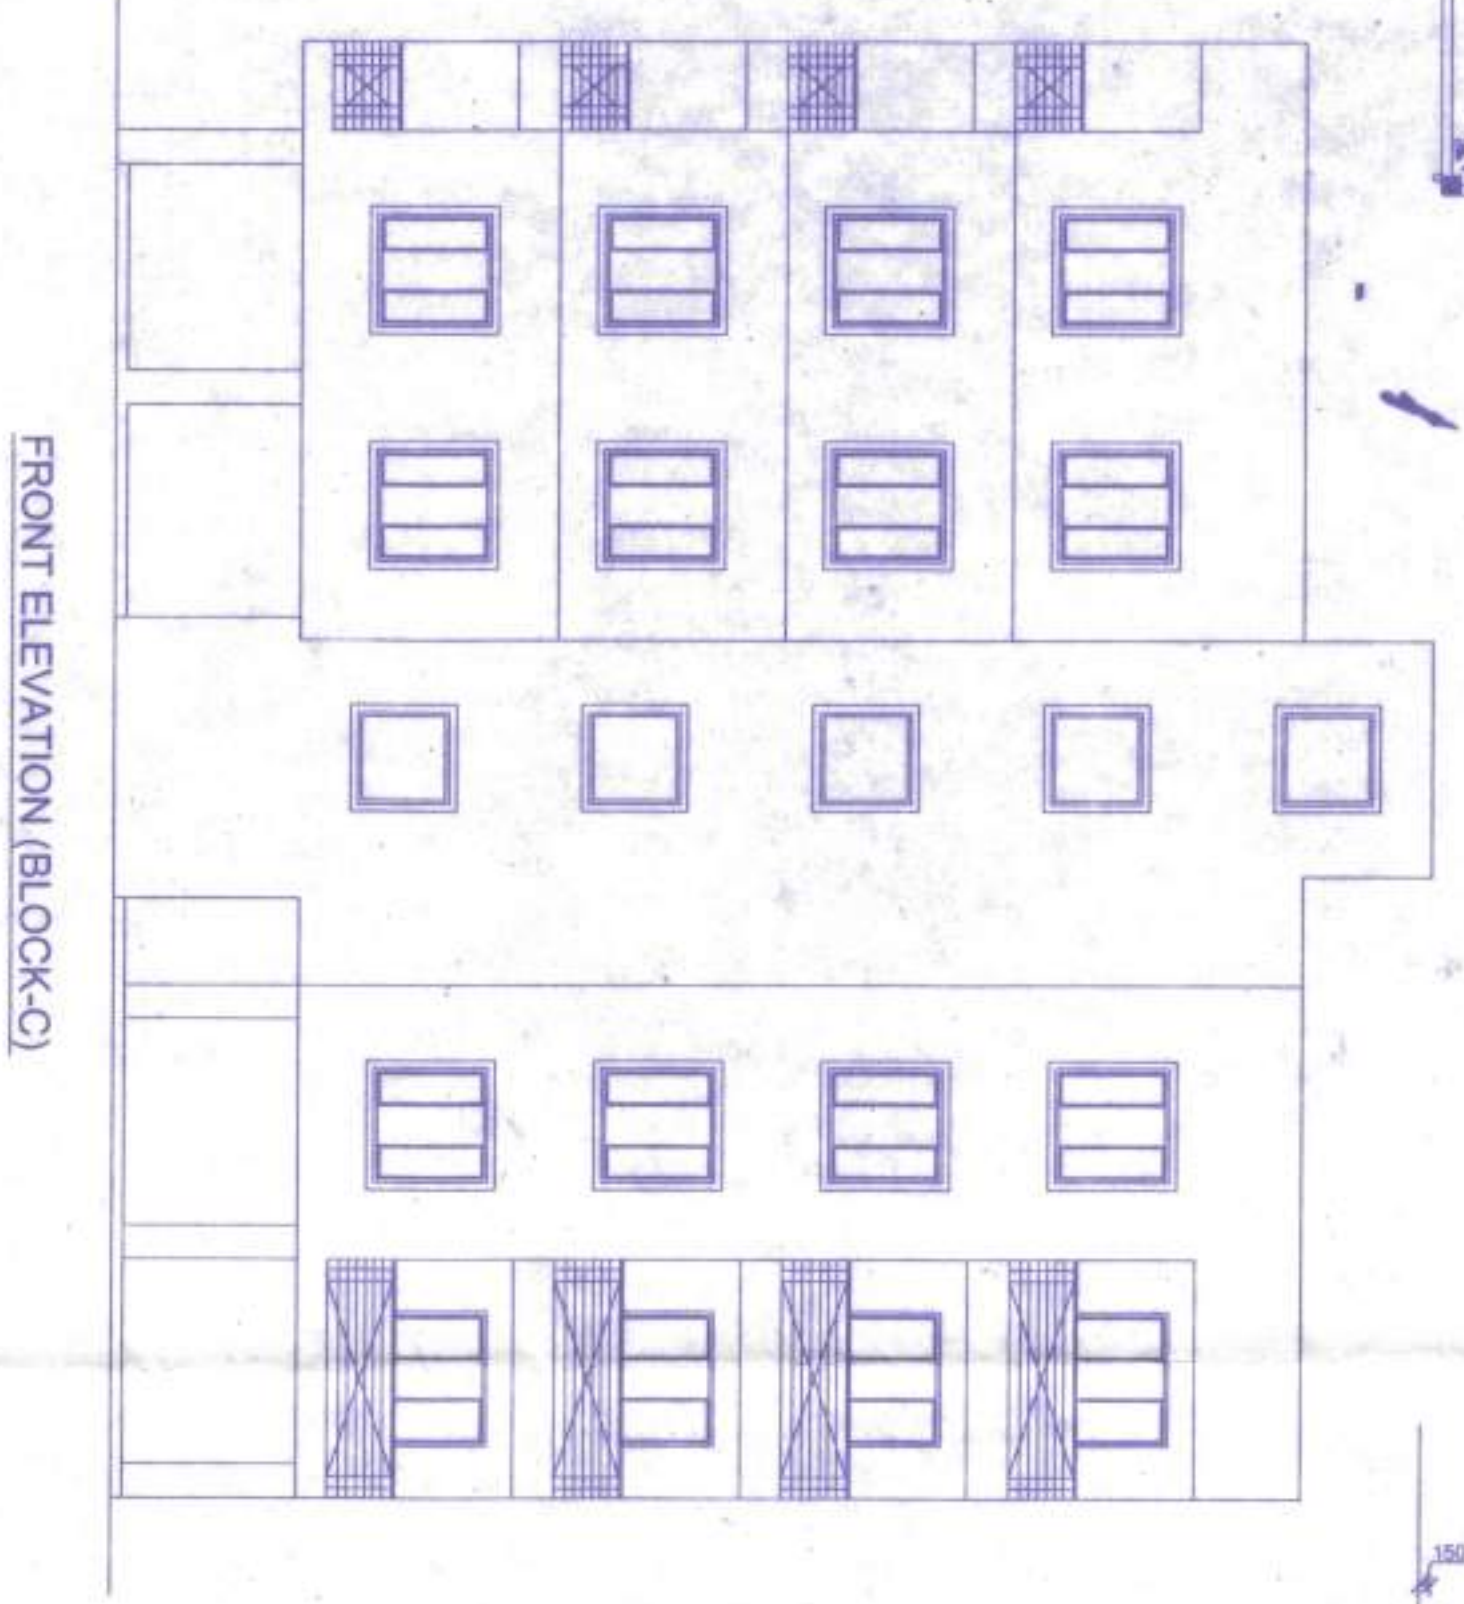


FRONT ELEVATION (BLOCK-C)
SCALE: 1:100

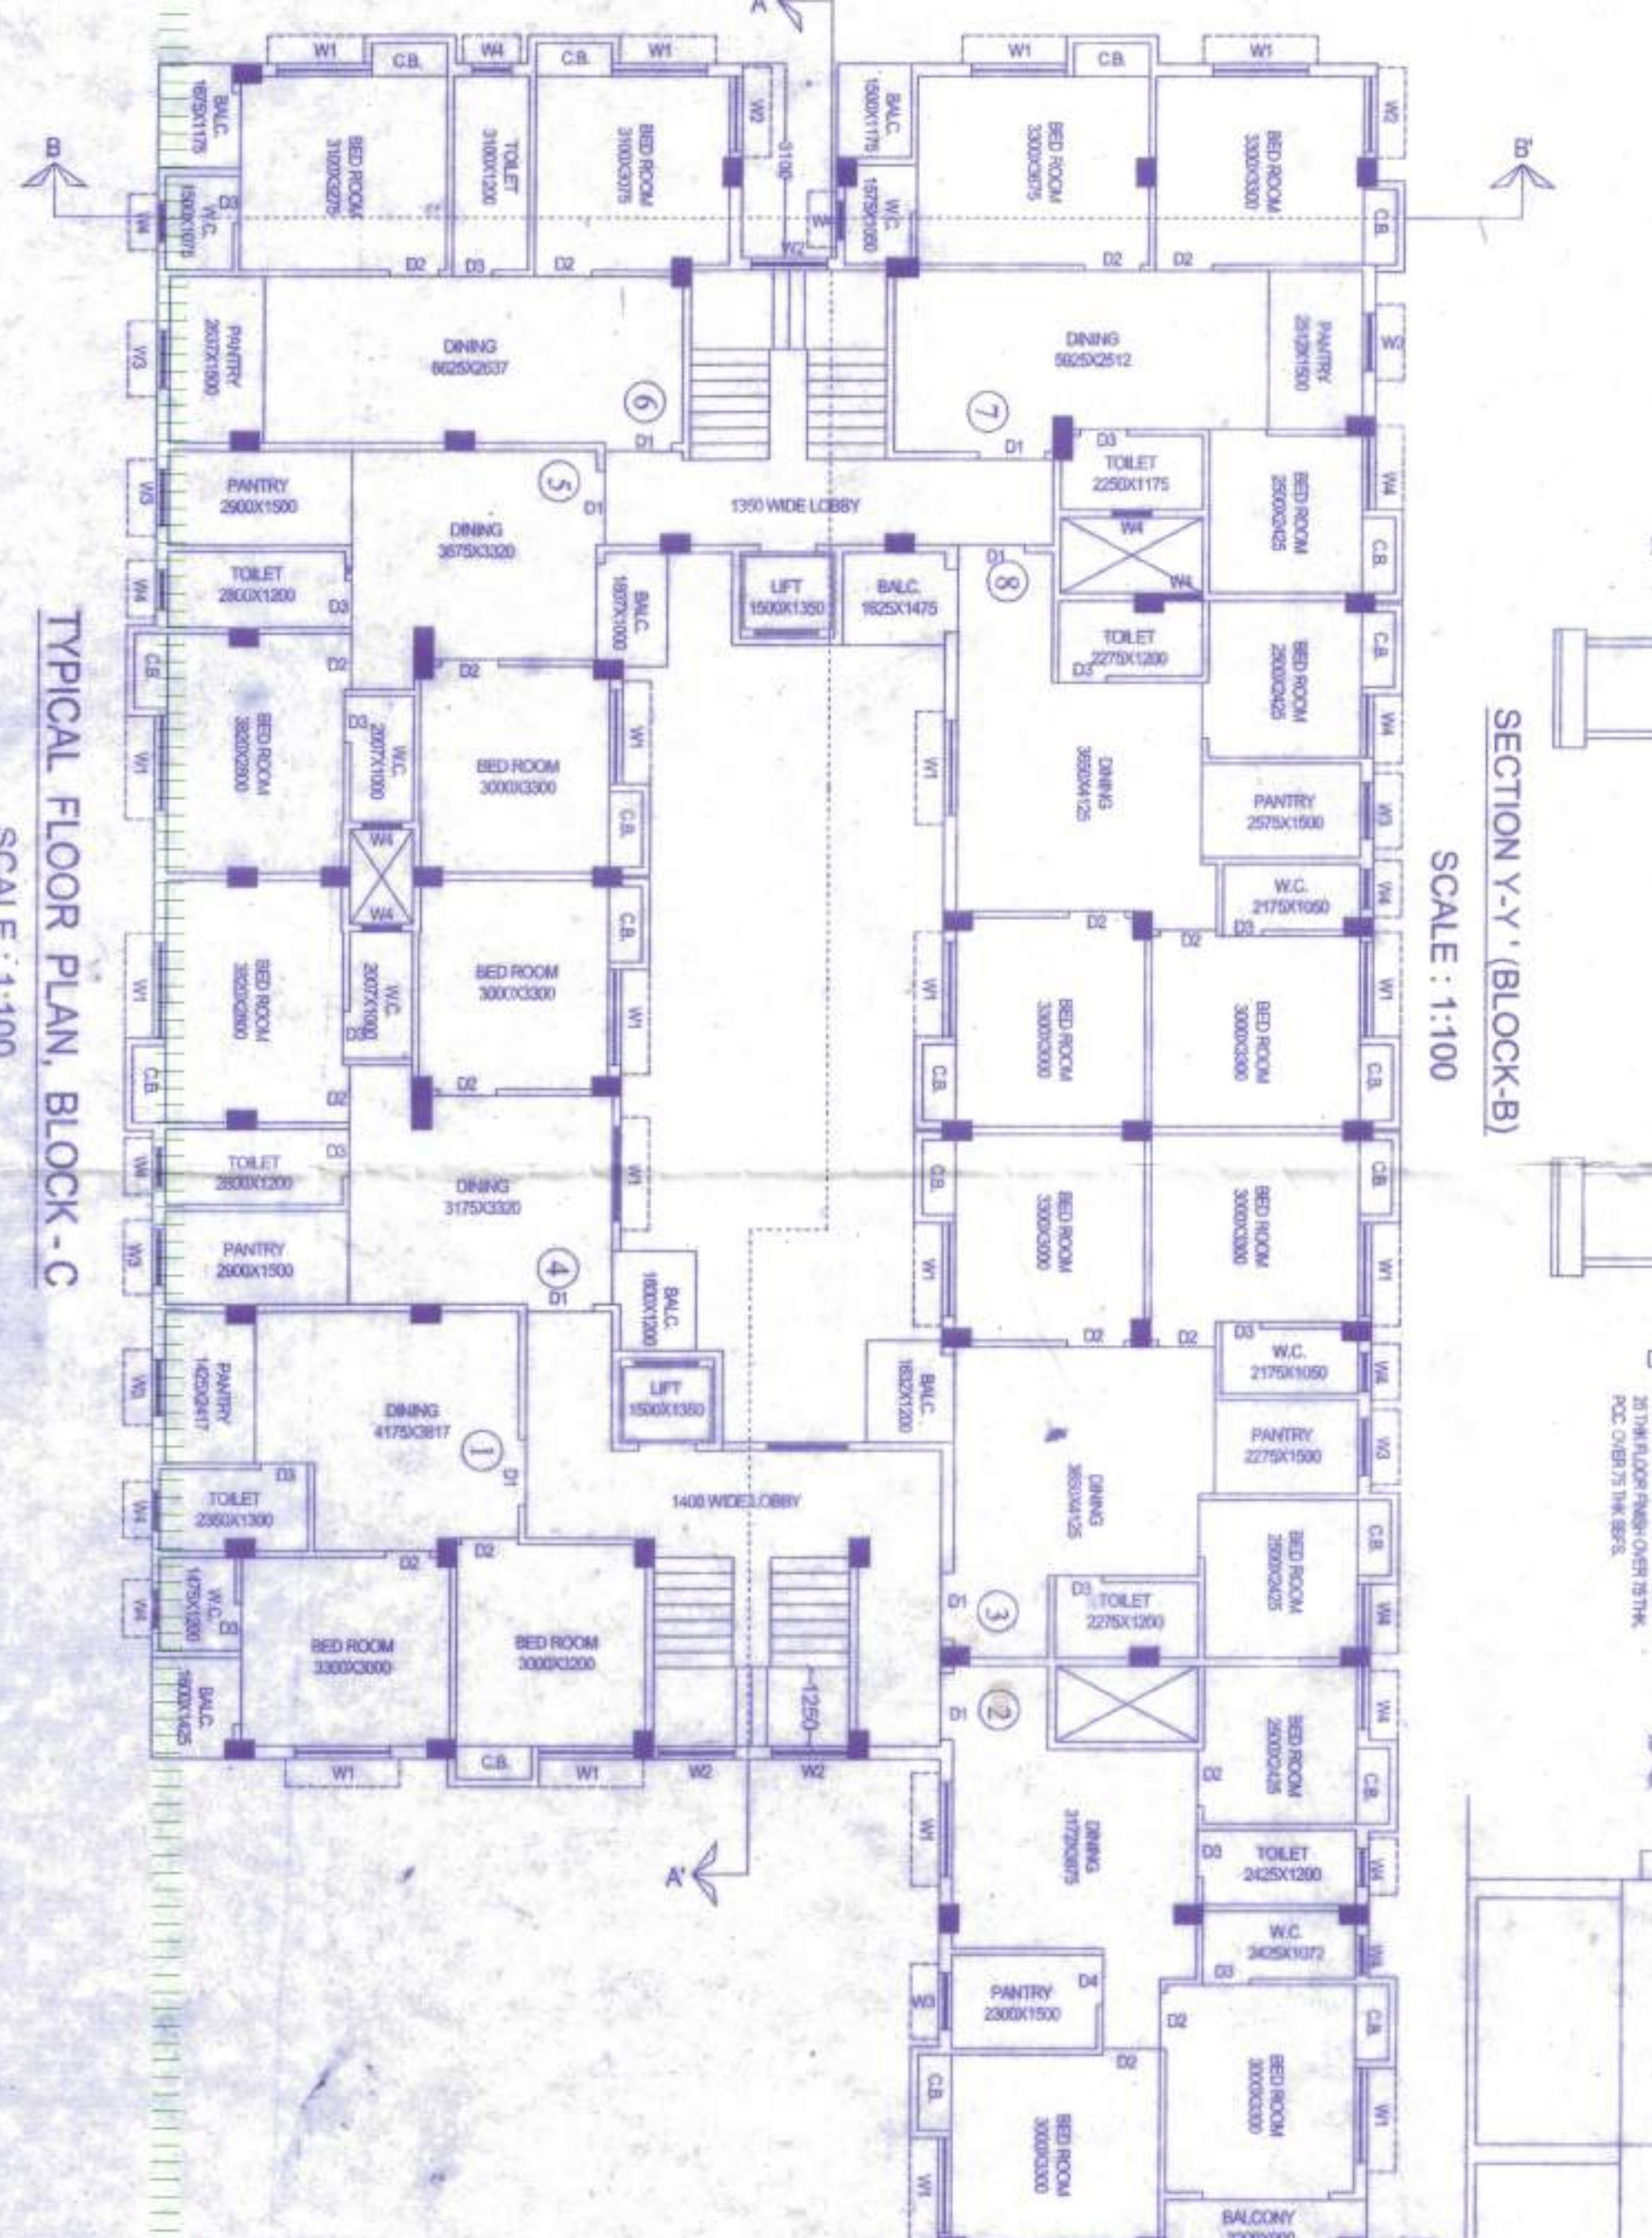


TYPICAL FLOOR PLAN, BLOCK-C
SCALE: 1:100

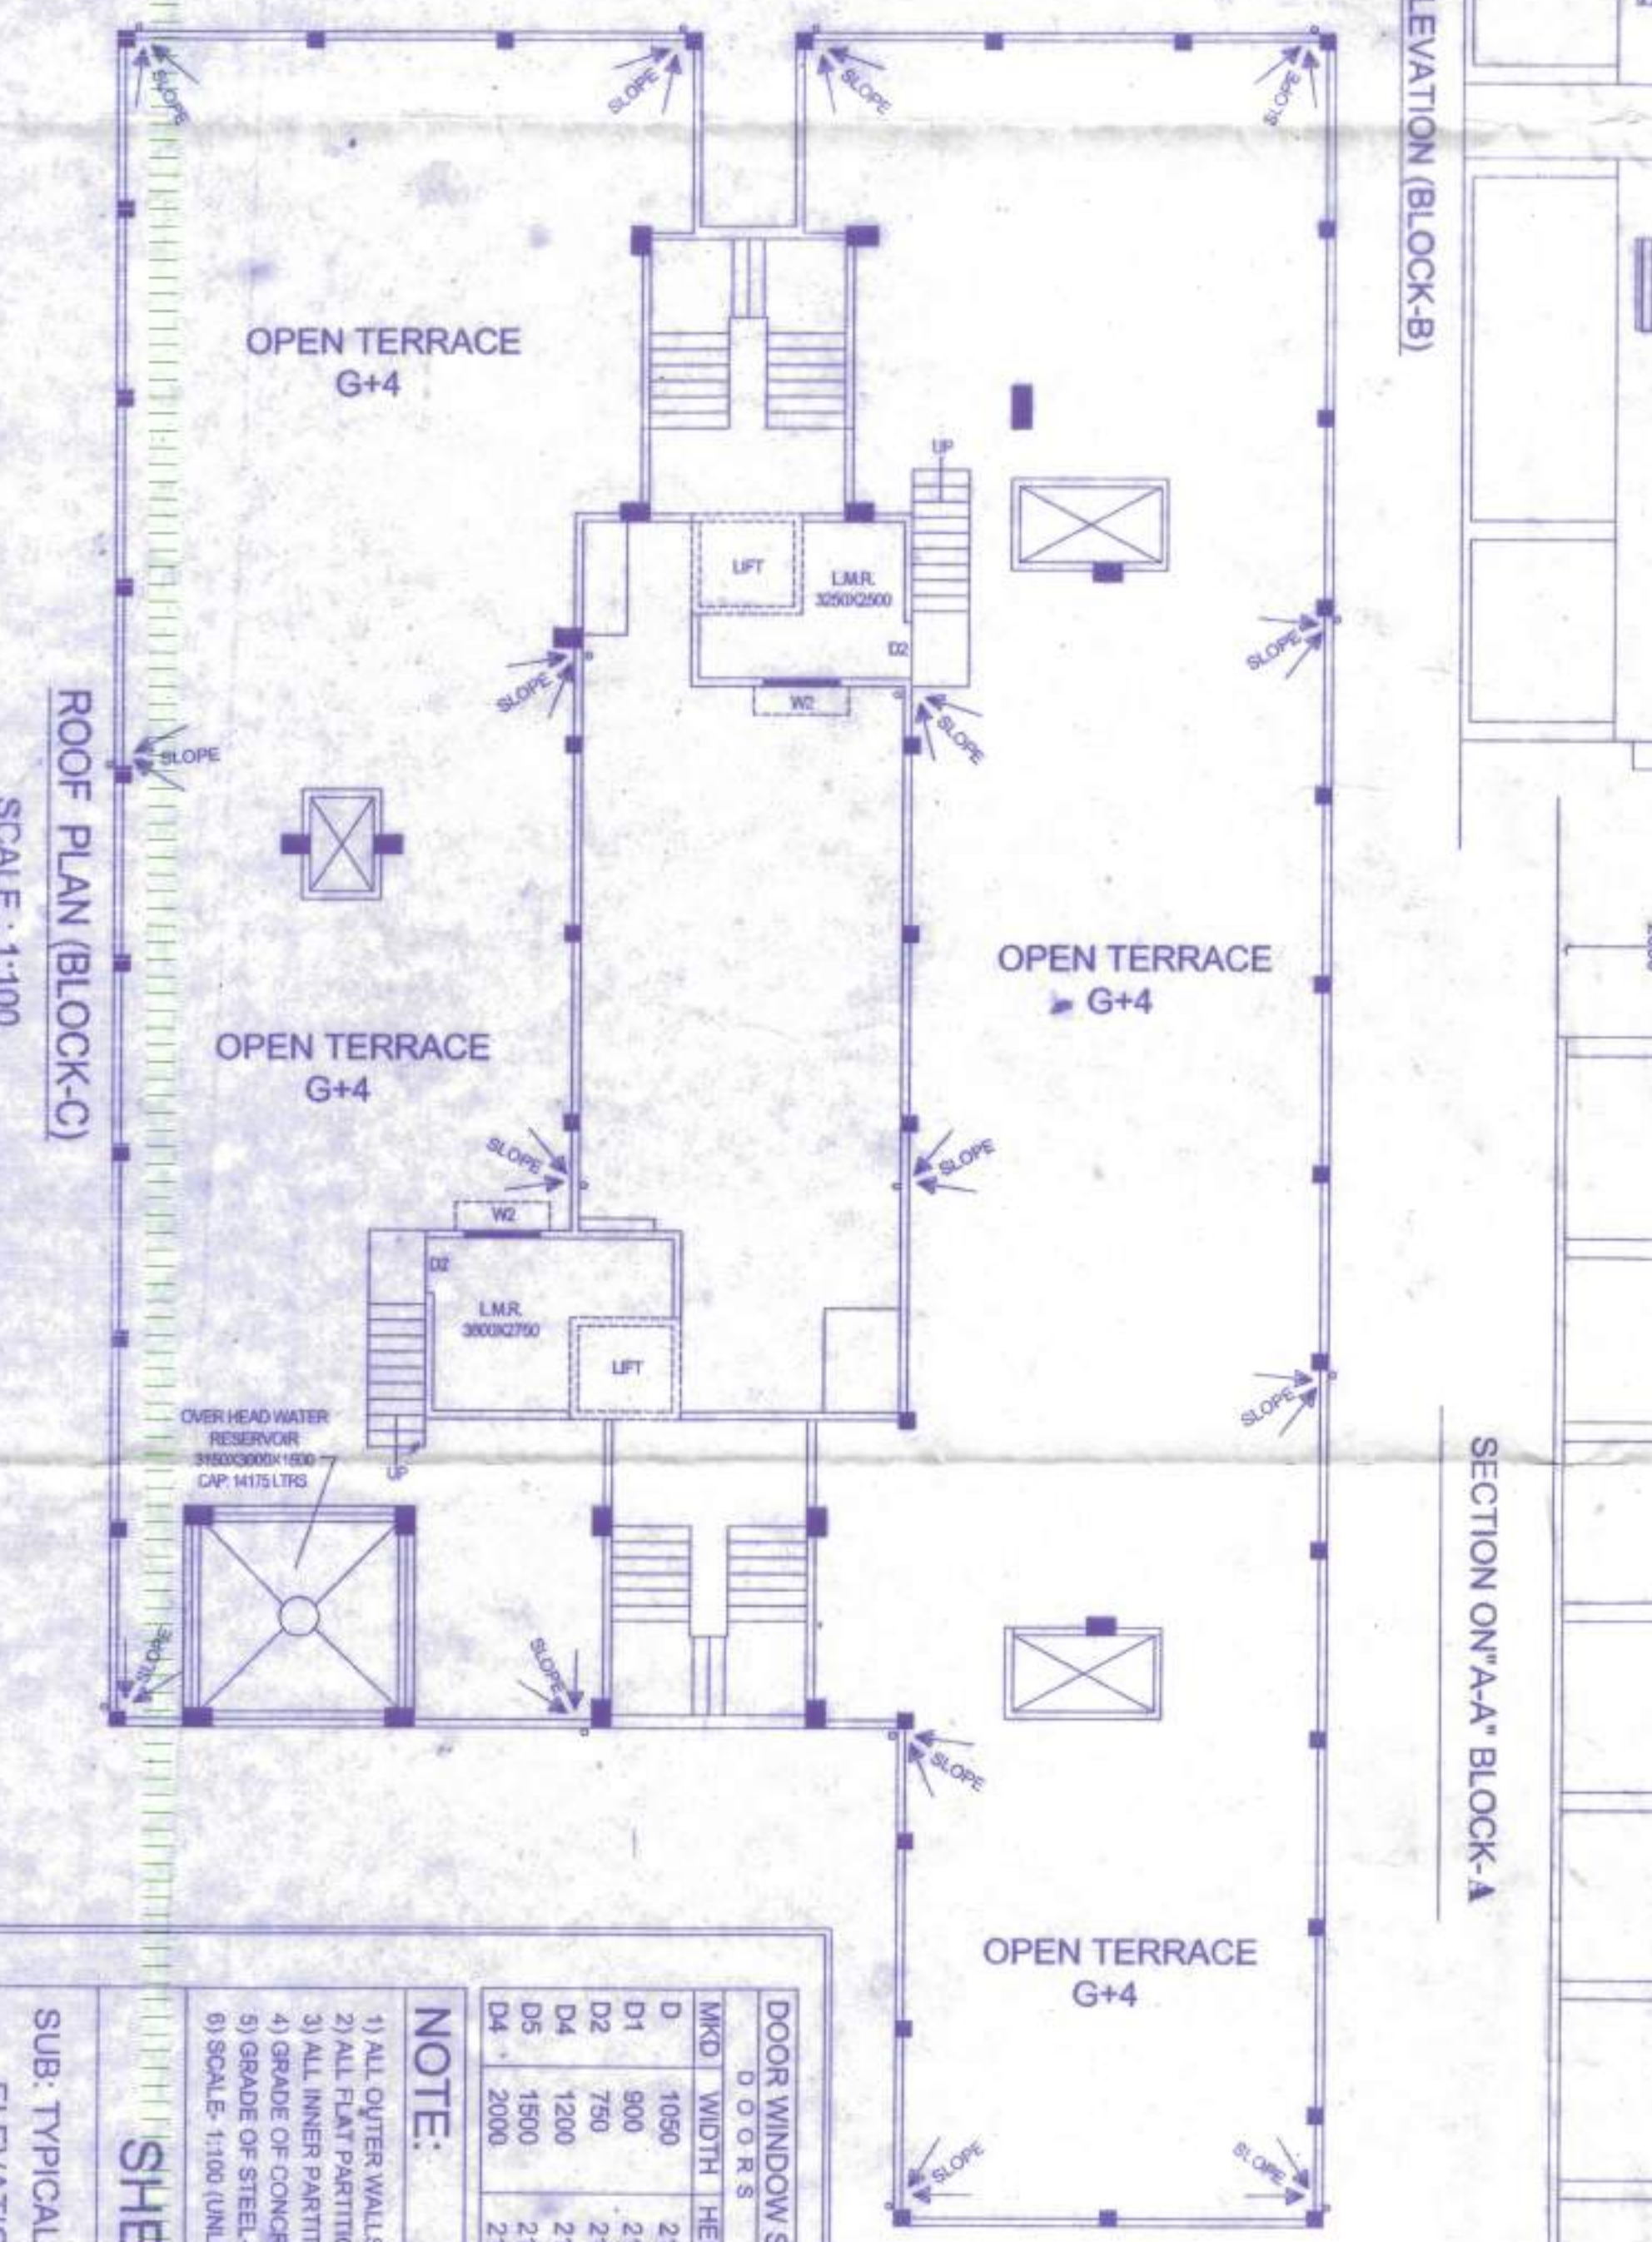


ROOF PLAN (BLOCK-C)
SCALE: 1:100

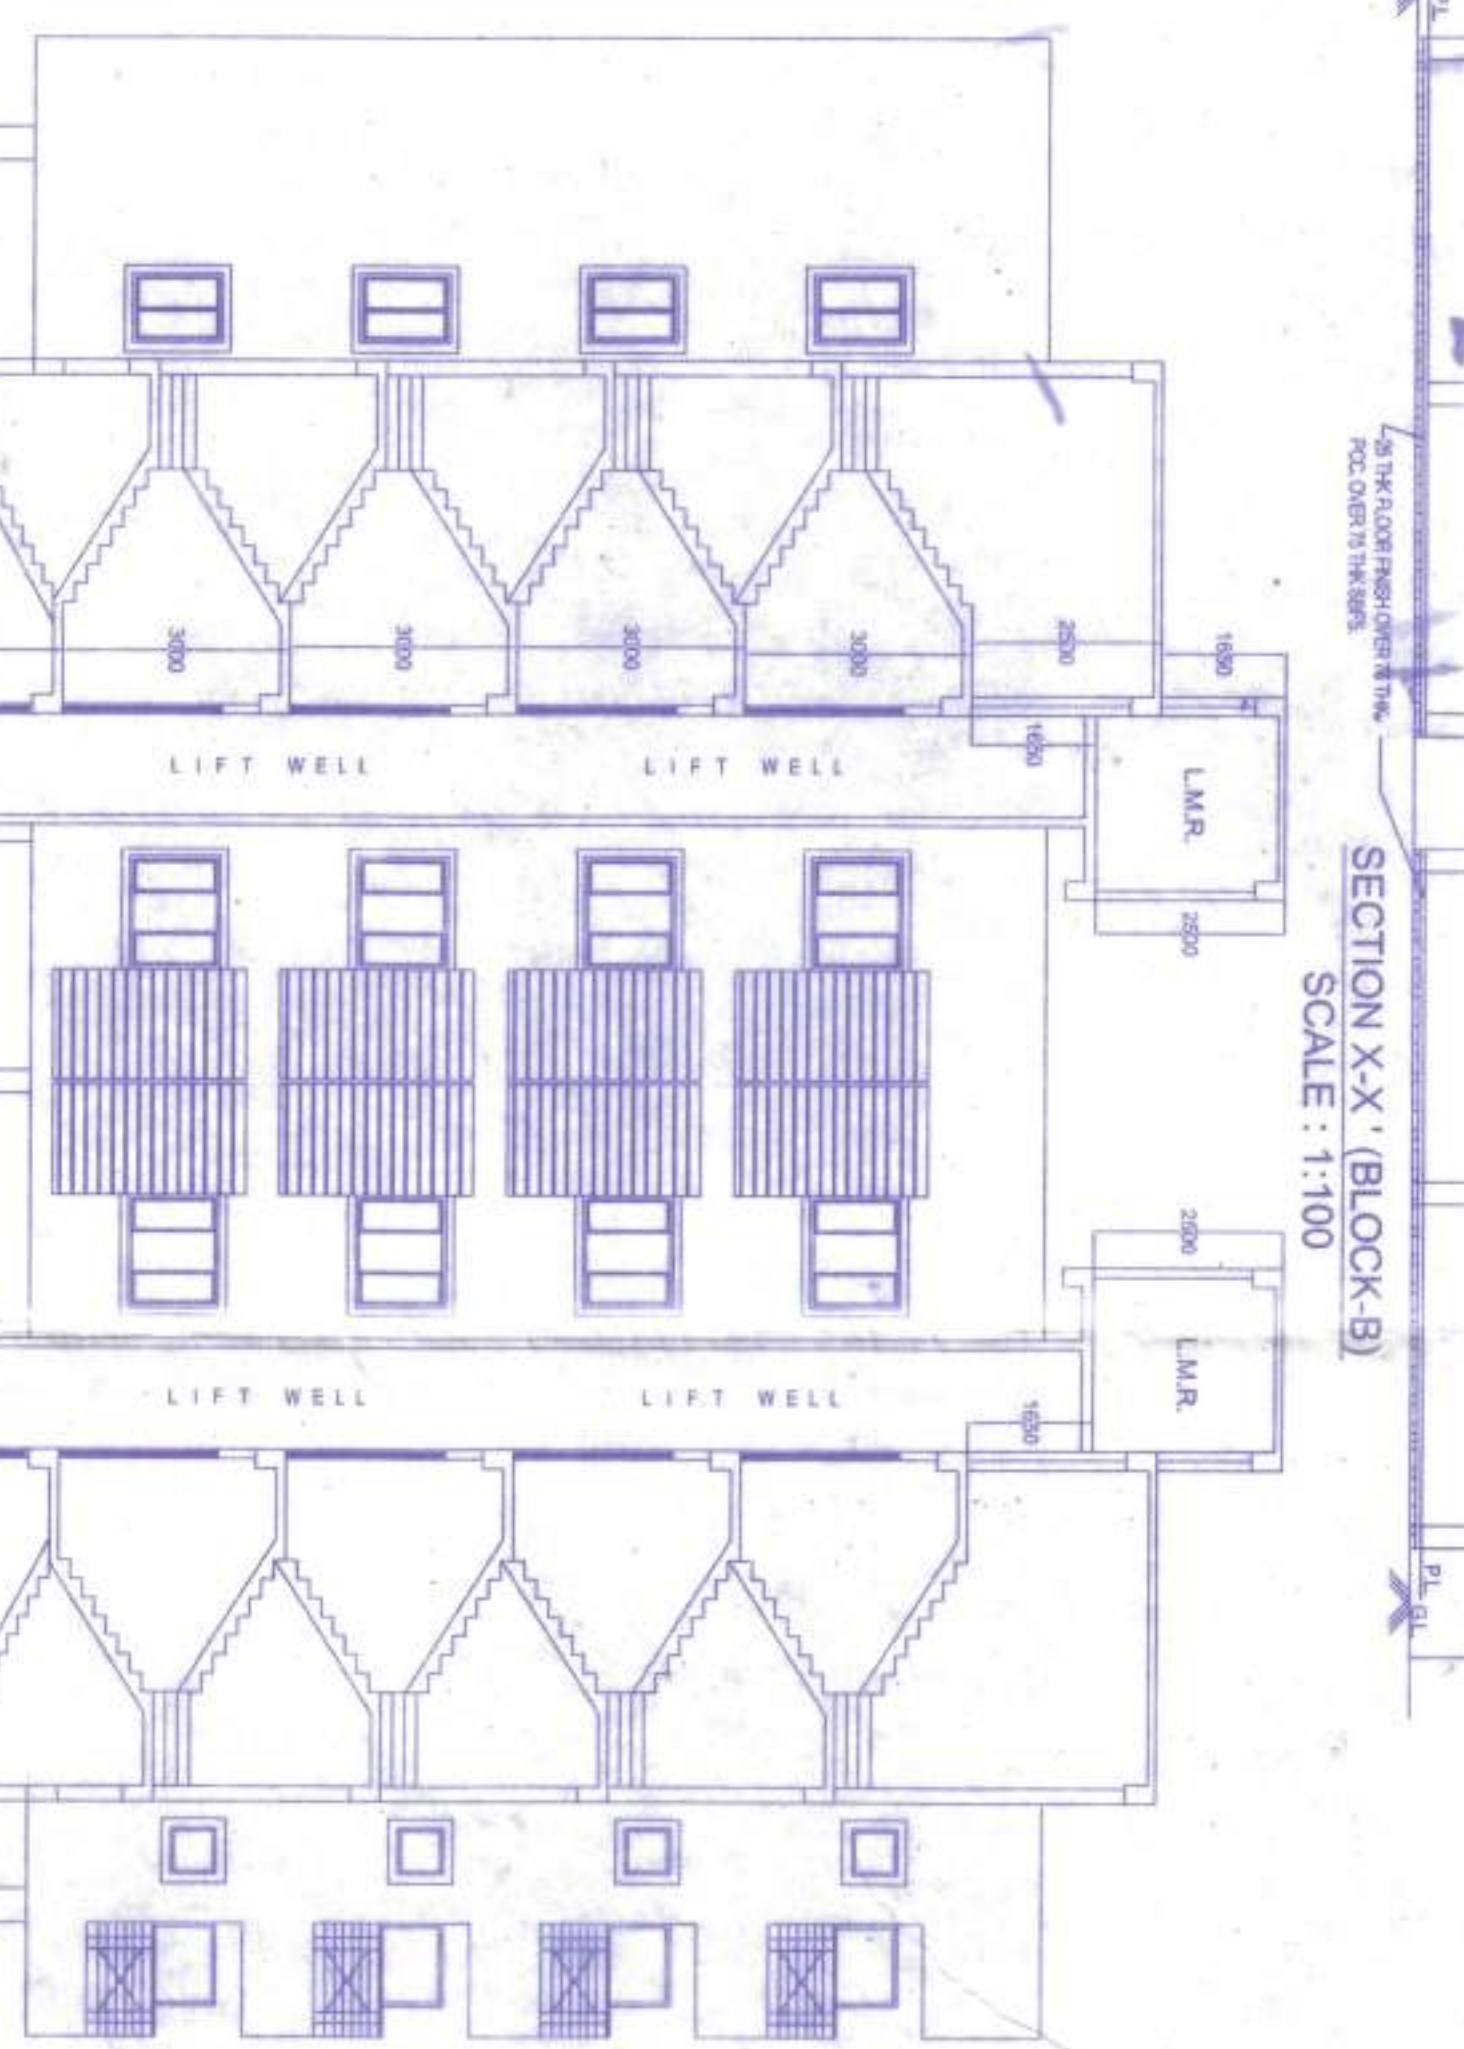

SECTION X-X' (BLOCK-B)
SCALE: 1:100

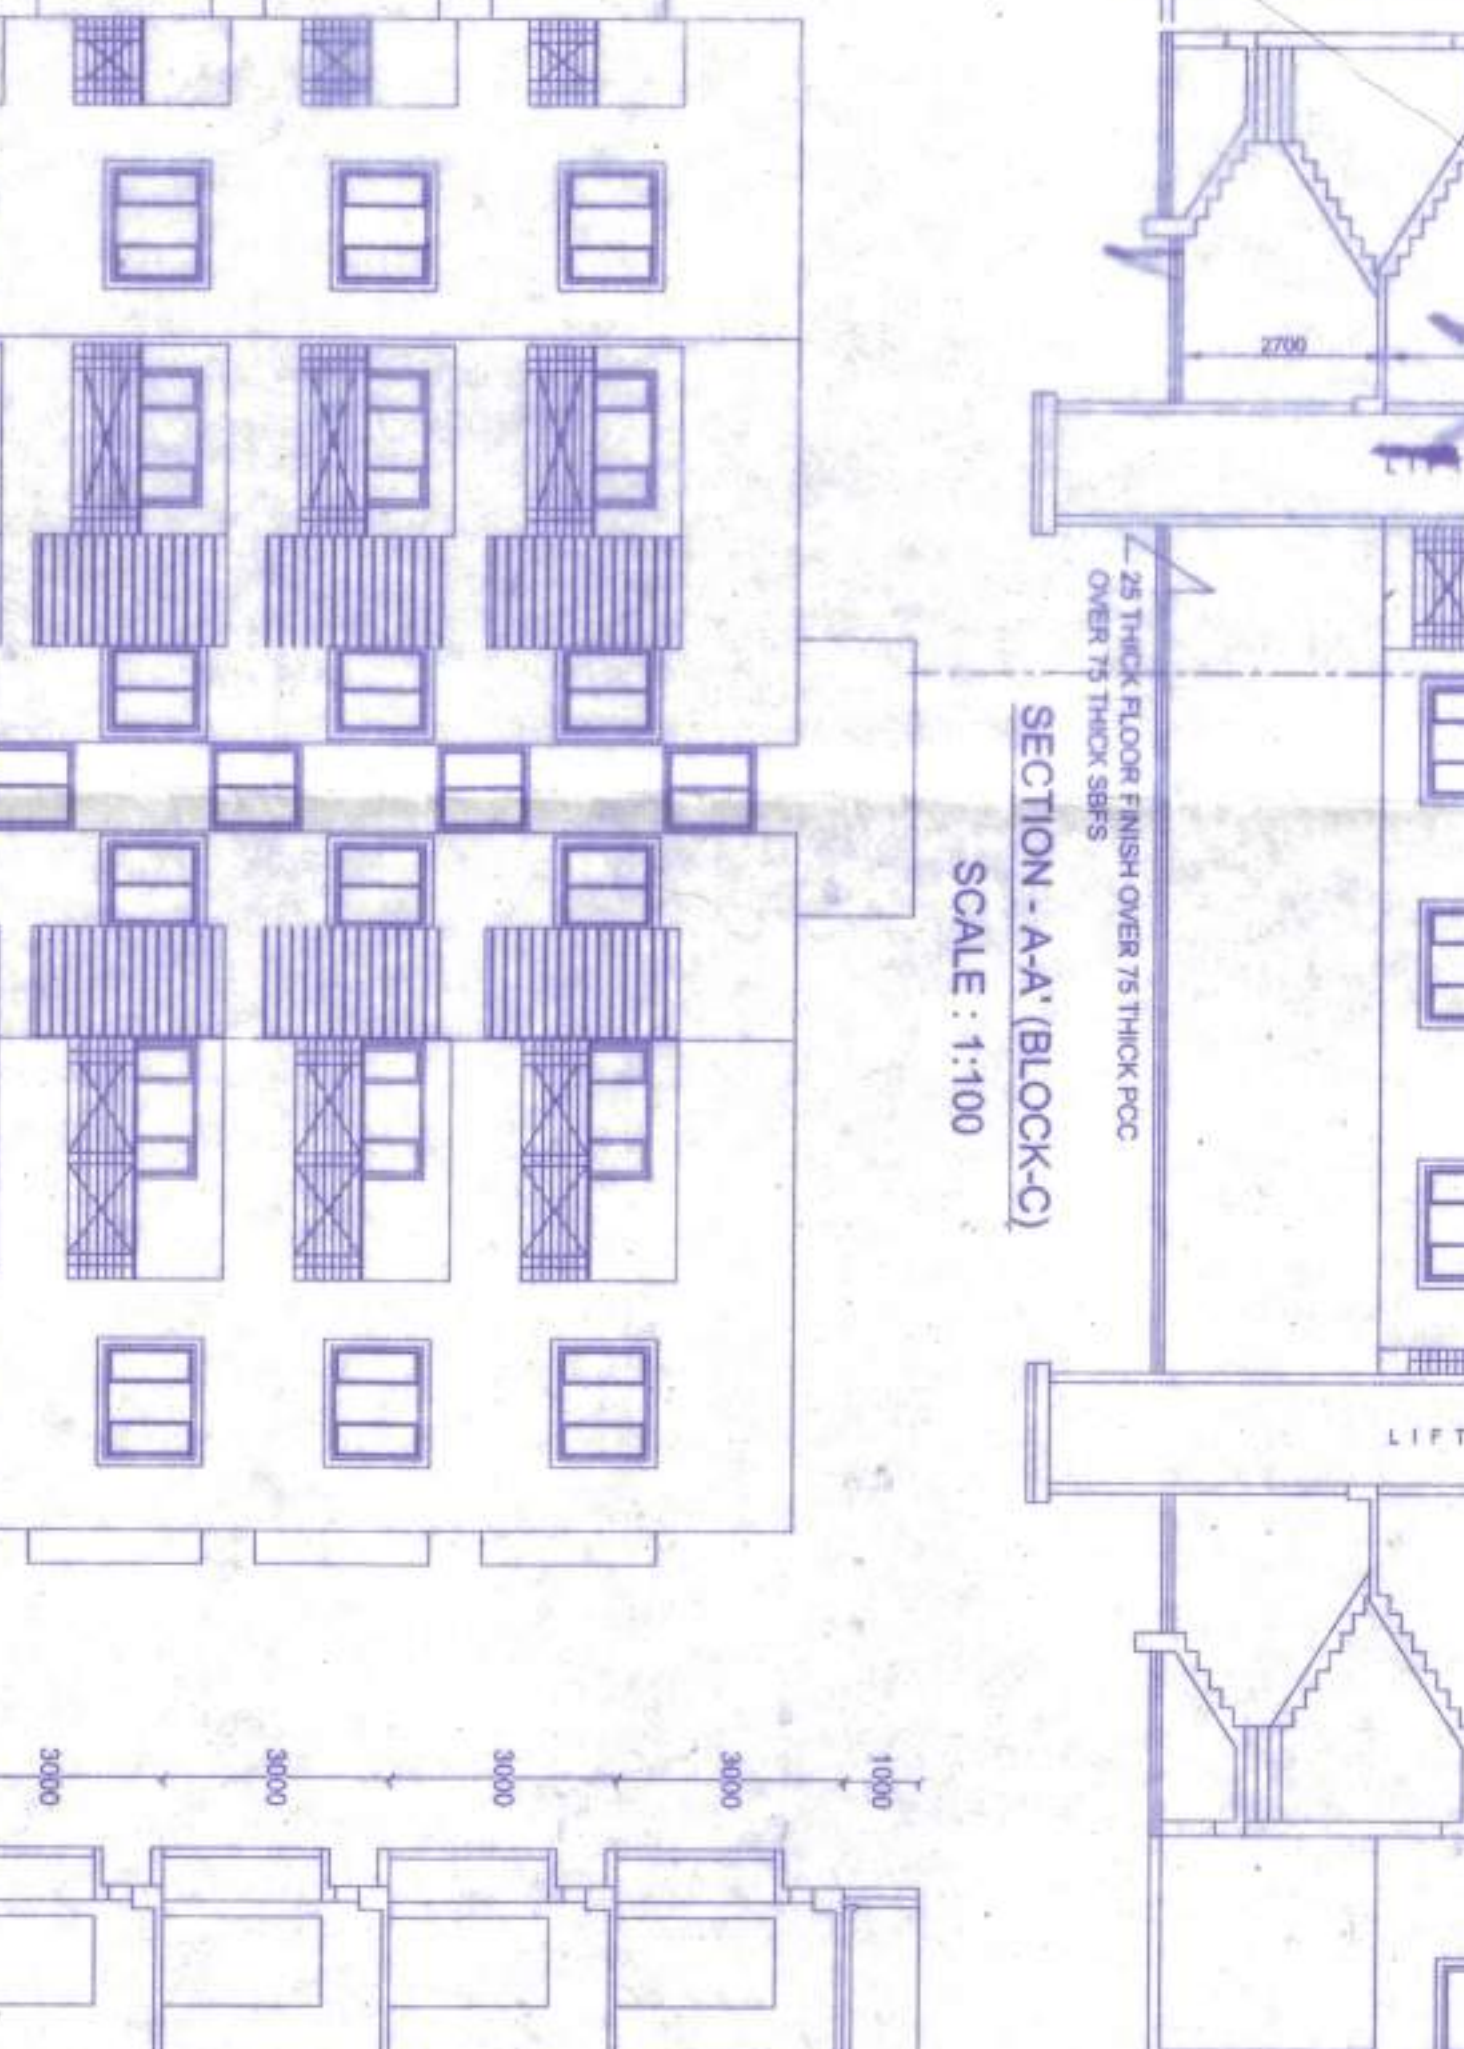

SECTION Y-Y' (BLOCK-B)
SCALE: 1:100

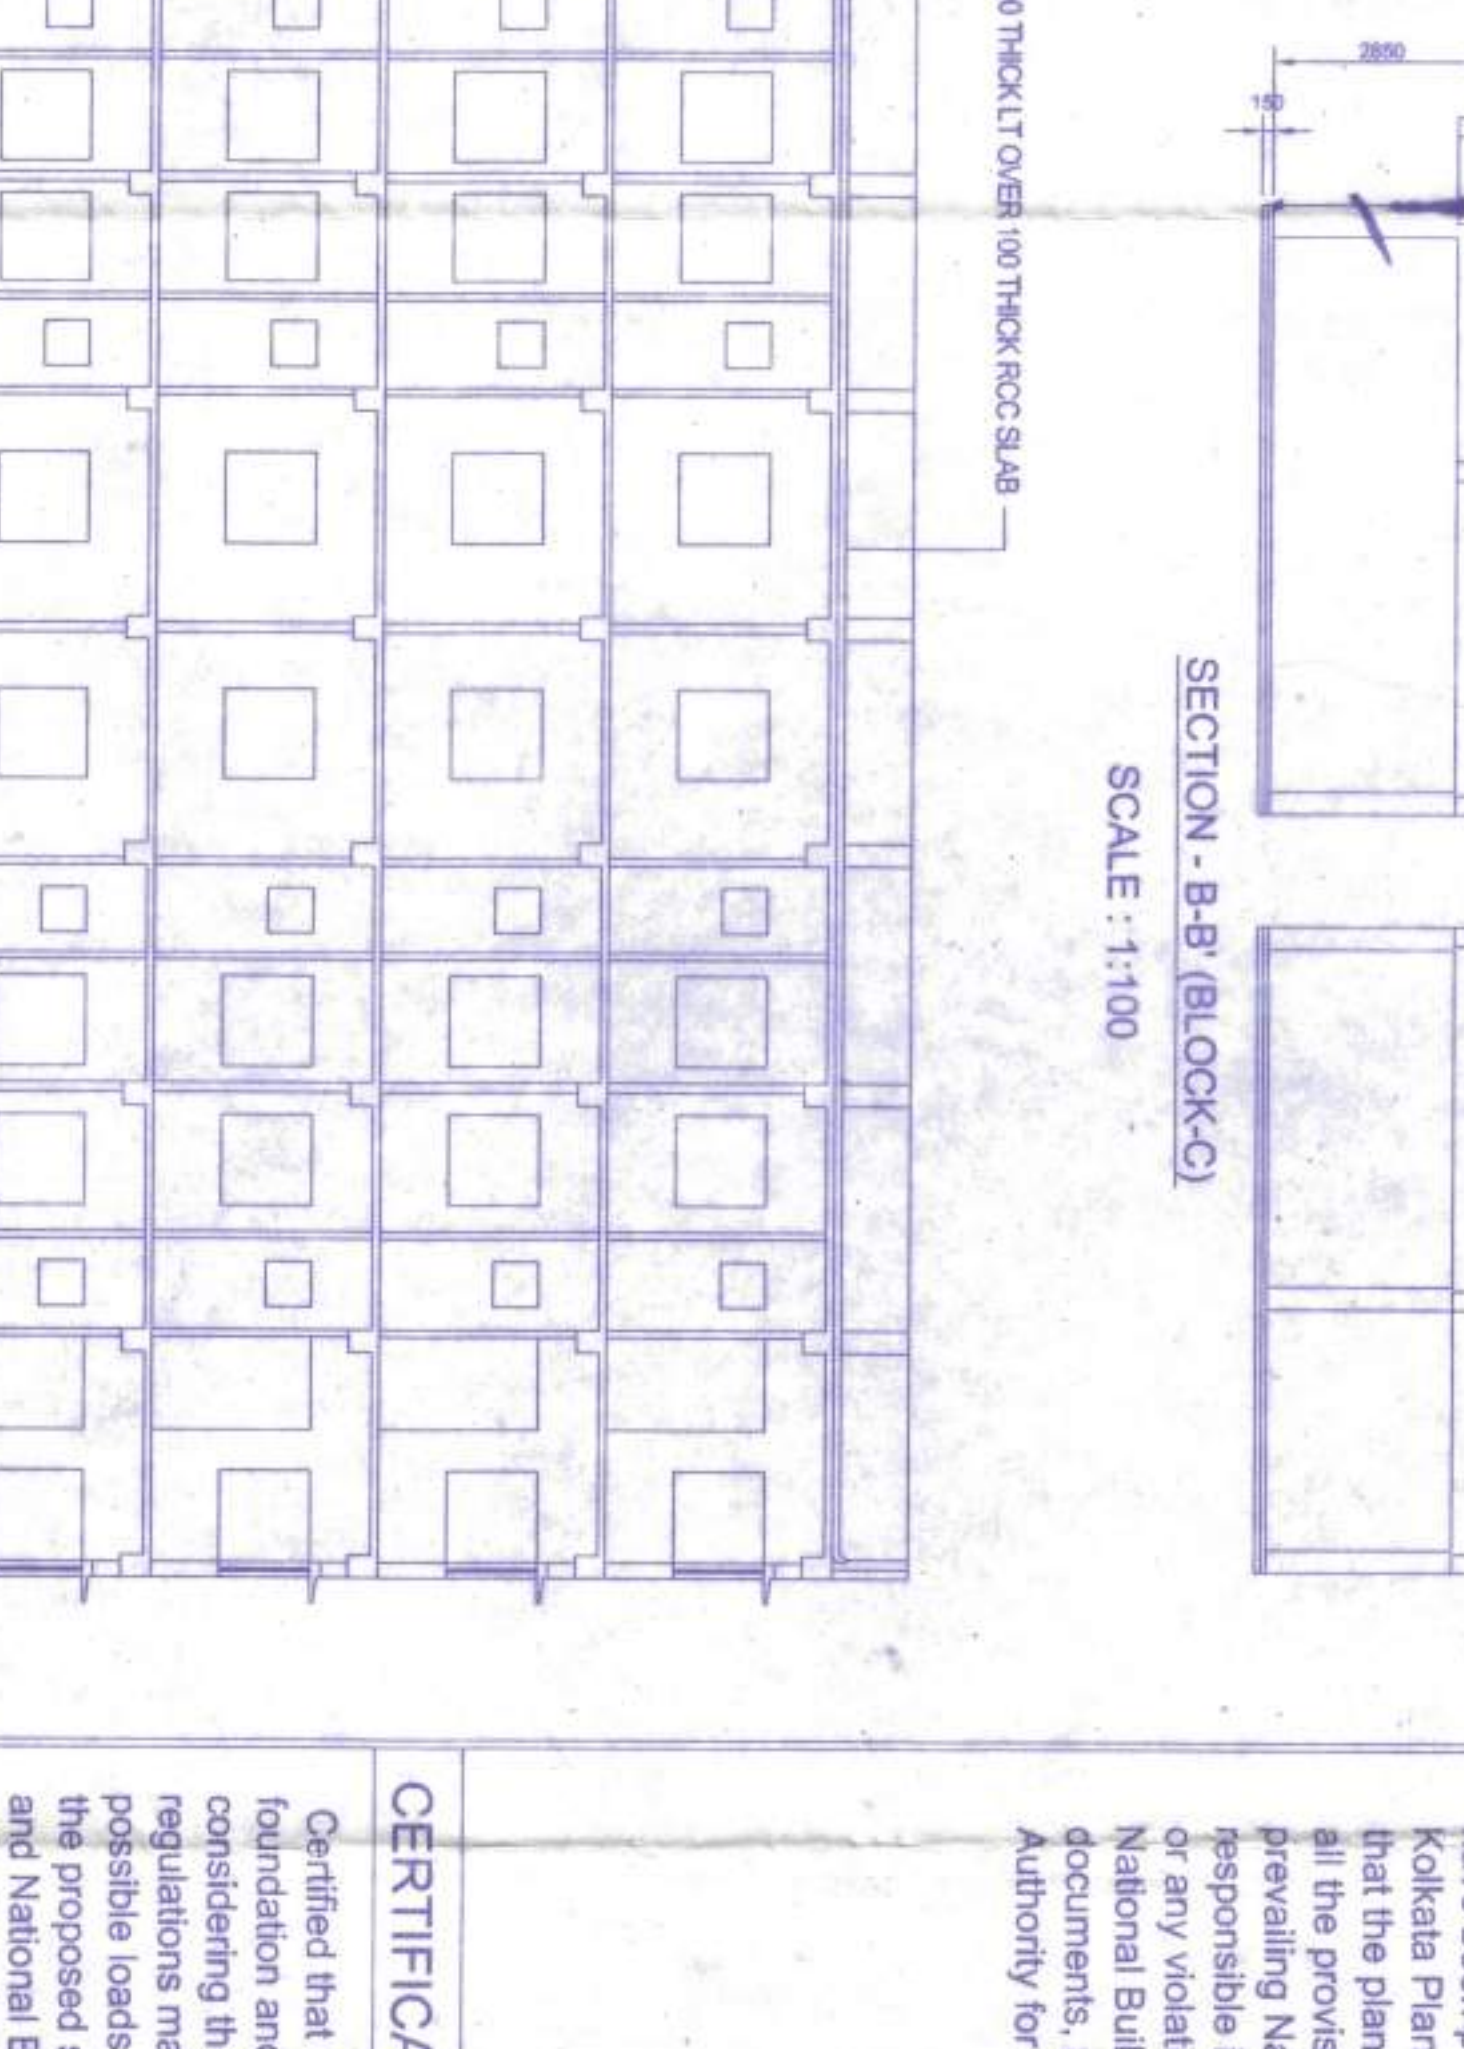

SECTION A-A' (BLOCK-C)
SCALE: 1:100



SECTION B-B' (BLOCK-C)
SCALE: 1:100



FRONT ELEVATION (BLOCK-A)
SCALE: 1:100



FRONT ELEVATION (BLOCK-B)
SCALE: 1:100



FRONT ELEVATION (BLOCK-C)
SCALE: 1:100

DOOR WINDOW SCHEDULE		
NO.	WIDTH	HEIGHT
1	1000	2100
2	1500	2100
3	2000	2100
4	2500	2100
5	3000	2100
6	3500	2100
7	4000	2100
8	4500	2100
9	5000	2100
10	5500	2100
11	6000	2100
12	6500	2100
13	7000	2100
14	7500	2100
15	8000	2100
16	8500	2100
17	9000	2100
18	9500	2100
19	10000	2100

NOTE:

- 1) ALL GATES SHALL BE 2000MM THICK.
- 2) ALL GATES SHALL BE 1.5% SLOPE.
- 3) ALL GATES SHALL BE 1.5% SLOPE.
- 4) ALL GATES SHALL BE 1.5% SLOPE.
- 5) ALL GATES SHALL BE 1.5% SLOPE.
- 6) ALL GATES SHALL BE 1.5% SLOPE.
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- 12) ALL GATES SHALL BE 1.5% SLOPE.
- 13) ALL GATES SHALL BE 1.5% SLOPE.
- 14) ALL GATES SHALL BE 1.5% SLOPE.
- 15) ALL GATES SHALL BE 1.5% SLOPE.
- 16) ALL GATES SHALL BE 1.5% SLOPE.
- 17) ALL GATES SHALL BE 1.5% SLOPE.
- 18) ALL GATES SHALL BE 1.5% SLOPE.
- 19) ALL GATES SHALL BE 1.5% SLOPE.
- 20) ALL GATES SHALL BE 1.5% SLOPE.

SHEET NO-2
SUB-TYPICAL FLOOR SECTION
ELEVATION ROOF PLAN

WANK BATHS PROJECTS LLP
5/17/17
Asstt. Manager of Owner
SIGNATURE OF OWNERS

CERTIFICATE OF ARCHITECT:
Certify that all the Architectural Drawing of the project at Durg No. 681, 682, 683, 684, 685, 686, L.R. Khatian Nos. 1277 & 1554 have been prepared by me complying with the New Town Khatian Planning Scheme (Building) Rules, 2014. I also certify that the provisions regarding the Fire Protection as per the prevailing National Building Code of India, I shall be held responsible if any incorrect information is furnished by me or any violation of provisions of these rules or the prevailing National Building Code is found in any of the drawing and/or construction. Authority for obtaining sanction.

Bhuvan Kumar Jana
Bhuvan Kumar Jana
Regd. No. AN/2003
Council of Architects

CERTIFICATE OF STRUCTURAL ENGINEER:
Certified that the structural drawing and design of both the foundation and superstructure of the building has been made considering the Soil Test Report, as per the rules and possible loads, seismic load, and the most conservative and by the proposed structure as per the Bureau of Indian Standard and National Building Code of India and certified that it is safe and stable in respect and these provisions shall be adhered to during the construction.

Dr. Dipak Majhi
Dr. Dipak Majhi
Regd. No. AN/2003
Council of Engineers

CERTIFICATE OF GEO-TECHNICAL ENGINEER:
THIS IS TO CERTIFY THAT THE SOIL TEST HAS BEEN PERFORMED BY ME TO THIS PROJECT.

Alka K.
Alka K.
Regd. No. AN/2003
Council of Engineers

CERTIFICATE OF OWNER:
CERTIFIED THAT I HAVE GONE THROUGH THE NATIONAL BUILDING CODE OF INDIA AND ALSO WERE BY THOSE RULES DURING AND AFTER CONSTRUCTION OF THE BUILDING.

Wank Baths Projects LLP
Wank Baths Projects LLP
Asstt. Manager of Owner
SIGNATURE OF OWNERS

PROPOSED G+4 STORIED RESIDENTIAL BUILDING PLAN OF SASWAT DEVELOPER PVT LTD SITUATED AT MOUZA, KALKAPUR, JL NO: 40, TOUZINO: 173, RSLR DAG NOS: 681, 682, 683, 684, 685, 686 LR KATHIAN NOS: 1270, 1554, POLICE STATION: RAARAHAT, DISTRICT: NORTH 24 PGS. UNDER PATHARGHATA GRAM PANCHAYET.

AREA STATEMENT:
7/3 DECIMAL OR 44K-00H-1SFT OR 2043.25 SQM
PROPOSED F.A.R = 2.25 (9822.31 SQM)
PROPOSED F.A.R = 2.189 (9385.36 SQM)
1) COVERED AREA OF GROUND FLOOR: 1471.16 SQM
2) COVERED AREA OF TYPICAL FLOOR: 1713.83 SQM
3) COVERED AREA OF TYPICAL FLOOR: 1713.83 SQM
4) COVERED AREA OF TYPICAL FLOOR: 1713.83 SQM
5) COVERED AREA OF TYPICAL FLOOR: 1713.83 SQM
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